# CITY OF MESQUITE, TEXAS WISER ROAD RECONSTRUCTION CITY CONTRACT NO. 2024-101



### CITY OFFICIALS

DANIEL ALEMAN, JR. MAYOR

JEFF CASPER DISTRICT 1

KENNY GREEN DISTRICT 2


JENNIFER VIDLER DISTRICT 3

TANDY BOROUGHS DISTRICT 4

B.W. SMITH DISTRICT 5

DEBBIE ANDERSON DISTRICT 6

CLIFF KEHELEY CITY MANAGER
CURTIS CASSIDY, P.E., CFM PUBLIC WORKS
DIRECTOR

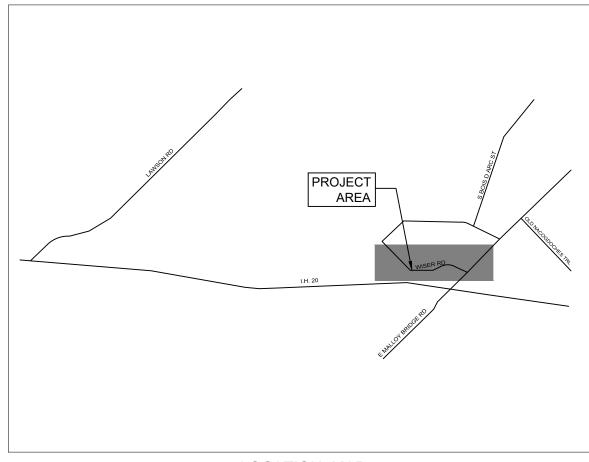

### **INDEX OF DRAWINGS**

- COVER SHEET
- 2. GENERAL NOTES 1
- 3. QUANTITIY SHEET
- 4. TYPICAL SECTIONS 1
- 5. TYPICAL SECTIONS 2
- . WISER RD 1 (ROADWAY MAINTENANCE) . WISER RD - 2 (ROADWAY MAINTENANCE)
- 7. WISER RD 2 (ROADWAT MAINTENANCE
- 9. WISER RD 4 (ROADWAY MAINTENANC
- 10. WISER RD 5 (ROADWAY MAINTENANCE
- 11. WISER RD 6 (ROADWAY MAINTENANC
- 12. WISER RD 1 (TRENCH LOCATION)
- 13. WISER RD 2 (TRENCH LOCATION)
- 14. WISER RD 3 (TRENCH LOCATION)
- 15. WISER RD 4 (TRENCH LOCATION)
- 16. WISER RD 5 (TRENCH LOCATION)

LOCATION MAP

# CITY OF MESQUITE

Public Works Department - Engineering Division 1515 N. Galloway Ave. P.O. Box 850137 Mesquite, TX 75149 Ph: 972-216-6955

**APR 2024** 





### GENERAL NOTES FOR CONSTRUCTION ACTIVITIES:

- ALL WORK SHALL CONFORM TO THE CITY OF MESQUITE'S GENERAL DESIGN STANDARDS. IN THE EVENT AN ITEM OF WORK IS 21. NOT COVERED IN THE PLANS OR THE CITY OF MESQUITE GENERAL DESIGN STANDARDS, THE MOST CURRENT NORTH CENTRAL TEXAS COUNCIL OF GOVERNMENTS (NCTCOG) STANDARD SPECIFICATIONS FOR PUBLIC WORKS CONSTRUCTION AND THE MOST CURRENT VERSION OF TEXAS DEPARTMENT OF TRANSPORTATION STANDARD SPECIFICATIONS FOR CONSTRUCTION AND MAINTENANCE OF HIGHWAYS, STREETS, AND BRIDGES SHALL APPLY WITH CONCURRING NOTIFICATION 22. TO THE CITY ENGINEER AND THE PROJECT ENGINEER. THE CITY ENGINEER SHALL HAVE FINAL DECISION ON ALL STRUCTION MATERIALS, METHODS, AND PROCEDURES.
- ALL CONTRACTORS AND DEVELOPERS. WITH THEIR EMPLOYEES AND AGENTS, SHALL COMPLY WITH ALL APPLICABLE EDERAL, STATE AND LOCAL SAFETY LAWS AND REGULATIONS, INCLUDING BUT NOT LIMITED TO THE OCCUPATIONAL SAFETY AND HEALTH ACT OF 1970, AND ORDINANCES RULES, REGULATIONS AND ORDERS OF ANY PUBLIC AUTHORITY HAVING JURISDICTION FOR THE SAFETY OF PERSONS OR PROPERTY TO PROTECT THEM FROM DEATH, INJURY, DAMAGE OR
- ALL COMMUNICATION BETWEEN THE CITY AND THE CONTRACTOR SHALL BE THROUGH THE ENGINEERING CONSTRUCTION INSPECTOR AND CITY ENGINEER ONLY. IT IS THE RESPONSIBILITY OF THE CONTRACTOR TO CONTACT THE APPROPRIATE DEPARTMENT FOR INSPECTIONS OF WORK NOT FALLING UNDER THE ENGINEERING CONSTRUCTION PERMIT
- PRIOR TO CONSTRUCTION, CONTRACTOR SHALL HAVE IN THEIR POSSESSION ALL NECESSARY PERMITS, PLANS, LICENSES, ETC. CONTRACTOR SHALL HAVE AT LEAST ONE SET OF APPROVED ENGINEERING PLANS AND SPECIFICATIONS ON-SITE AT
- IT IS THE CONTRACTOR'S RESPONSIBILITY TO NOTICY LITH ITY COMPANIES TO ARRANGE FOR EXACT LOCATIONS AT LEAST 48 HOURS PRIOR TO BEGINNING CONSTRUCTION. THE COMPLETENESS AND ACCURACY OF THE UTILITY DATA SHOWN ON THE PLANS IS NOT GUARANTEED. THE CONTRACTOR IS RESPONSIBLE FOR VERIFYING THE DEPTH AND LOCATION OF EXISTING UNDERGROUND UTILITIES PRIOR TO EXCAVATING, TRENCHING, OR DRILLING AND SHALL BE REQUIRED TO TAKE ANY PRECAUTIONARY MEASURES TO PROTECT ALL LINES SHOWN AND / OR ANY OTHER UNDERGROUND UTILITIES NOT ON RECORD OR NOT SHOWN ON THE PLANS. THE CONTRACTOR WILL BE RESPONSIBLE FOR DAMAGES TO UTILITIES IF THE DAMAGE IS CAUSED BY NEGLIGENCE OR FAILURE TO HAVE LOCATES PERFORMED.
  - CITY OF MESQUITE UTILITIES 972-216-6940 CITY OF MESQUITE TRAFFIC
- VERIFICATION OF THE CONDITION OF EXISTING CITY UTILITIES PRIOR TO CONNECTIONS SHALL BE THE RESPONSIBILITY OF E CONTRACTOR. THE CONTRACTOR SHALL REQUEST FOR LINE LOCATES AS DIRECTED IN ITEM #5
- CONTRACTOR SHALL LOCATE AND PROTECT ALL EXISTING LANDSCAPE IRRIGATION SYSTEMS. DAMAGE TO EXISTING IRRIGATION SYSTEMS SHALL BE RESTORED TO EQUAL OR BETTER CONDITION BY A LICENSED IRRIGATOR AT THE
- CONTRACTOR SHALL BE RESPONSIBLE FOR ANY DAMAGE TO EXISTING FACILITIES OR ADJACENT PROPERTIES DURING CONSTRUCTION. ANY REMOVAL OR DAMAGE TO EXISTING FACILITIES OR ADJACENT PROPERTIES SHALL BE REPLACED OR REPAIRED TO EQUAL OR BETTER CONDITION BY THE CONTRACTOR. THE CONTRACTOR SHALL COORDINATE ALL REPAIRS TO PRIVATE PROPERTY WITH THE PROPERTY OWNER. CONTRACTOR SHALL PAY AND/OR SETTLE WITH PRIVATE PROPERTY OWNER FOR ALL COSTS RELATED TO ANY DAMAGE. FOR MORE DETAIL, REFER TO NCTCOG 107.24.
- TESTING AND INSPECTION OF MATERIALS SHALL BE PERFORMED BY A COMMERCIAL TESTING LABORATORY APPROVED BY THE CITY. CONTRACTOR SHALL FURNISH MATERIALS OR SPECIMENS FOR TESTING, AND SHALL FURNISH SUITABLE EVIDENCE THAT THE MATERIALS PROPOSED TO BE INCORPORATED INTO THE WORK ARE IN ACCORDANCE WITH THE SPECIFICATIONS. ALL TESTING AND RE-TESTING COSTS SHALL BE THE RESPONSIBILITY OF THE CONTRACTOR. FOR MORE DETAIL, REFER TO NCTCOG 106.5.
- 10 CONTRACTOR SHALL NOTICY THE CITY AT LEAST 48 HOLIRS PRIOR TO REGINNING ANY CONSTRUCTION
- ALL SHOP DRAWINGS. WORKING DRAWINGS OR OTHER DOCUMENTS WHICH REQUIRE REVIEW BY THE CITY SHALL BE SUBMITTED BY THE CONTRACTOR SUFFICIENTLY IN ADVANCE OF SCHEDULED CONSTRUCTION TO ALLOW NO LESS THAN 10 BUSINESS DAYS FOR REVIEW AND RESPONSE BY THE CITY.
- 12. CONTRACTOR SHALL BE RESPONSIBLE FOR ALL REQUIRED CONSTRUCTION SURVEYING AND STAKING AND SHALL NOTIFY THE CITY OF ANY DISCREPANCIES PRIOR TO PROCEEDING WITH ANY WORK FOR MORE DETAIL REFER TO NCTCOG 105.4
- CONTRACTOR SHALL BE RESPONSIBLE FOR PROTECTING ALL SURVEY MARKERS INCLUDING IRON RODS, PROPERTY CORNERS, OR SURVEY MONUMENTS WITHIN THE LIMITS OF CONSTRUCTION AND OUTSIDE RIGHT-OF-WAY DURING CONSTRUCTION. ANY SURVEY MARKERS DISTURBED DURING CONSTRUCTION SHALL BE REPLACED BY THE CONTRACTOR
- CONTRACTOR SHALL NOT STORE MATERIALS. EQUIPMENT OR OTHER CONSTRUCTION ITEMS ON ADJACENT PROPERTIES OR RIGHT-OF-WAY WITHOUT THE PRIOR WRITTEN CONSENT OF THE PROPERTY OWNER AND THE CITY. THE PROJECT SHALL NOT BE ACCEPTED UNTIL THE CONTRACTOR PROVIDES A LETTER FROM THE PROPERTY OWNER STATING THEY ARE
- UNUSABLE EXCAVATED MATERIAL OR CONSTRUCTION DEBRIS SHALL BE REMOVED AND DISPOSED OF OFFSITE AT AN
- ALL SIGNAGE SHALL BE INSTALLED IN ACCORDANCE WITH THE LATEST EDITION OF THE TEXAS MANUAL ON UNIFORM TRAFFIC CONTROL DEVICES (TMUTCD)

### GENERAL NOTES FOR EROSION CONTROL/STORM WATER POLLUTION PREVENTION:

- THE CONTRACTOR SHALL COMPLY WITH THE CITY OF MESQUITE'S STORM WATER ORDINANCE, THE TDPES GENERAL CONSTRUCTION PERMIT TXR150000 AND ANY OTHER STATE AND/OR LOCAL REGULATIONS.
- CONTRACTOR IS RESPONSIBLE FOR KEEPING STREETS AND DRIVEWAYS ADJACENT TO THE PROJECT FREE OF MIJD AND DEBRIS AT ALL TIMES. CONTRACTOR SHALL CLEAN UP AND REMOVE ALL LOOSE MATERIAL RESULTING FROM CONSTRUCTION OPERATIONS, STOCKPILING OR STAGING OF MATERIALS WILL NOT BE ALLOWED IN RIGHT-OF-WAY WITHOUT PRIOR AUTHORIZATION. THE CONTRACTOR SHALL TAKE ALL AVAILABLE PRECAUTIONS TO CONTROL DUST. ANY DIRT, MUD OR DEBRIS TRACKED OFFSITE SHALL BE CLEANED UP BY THE CONTRACTOR IMMEDIATELY.
- ALL EROSION CONTROL DEVICES SHOWN ON THE PLANS RELEASED FOR CONSTRUCTION SHALL BE INSTALLED IN ACCORDANCE WITH THE SWPPP SEQUENCING PRIOR TO COMMENCING ANY EARTH DISTURBING ACTIVITIES. FAILURE TO INSTALL THE EROSION CONTROL DEVICES BEFORE STARTING THE EARTH DISTURBING ACTIVITIES MAY RESULT IN SANCTIONS INCLUDING, BUT NOT LIMITED TO, WITHHOLDING OF RELEASE OF CONSTRUCTION PERMITS, INSPECTIONS, PAYMENT OF CITY FUNDED PORTIONS OF THE PROJECT, SUSPENSION OF CONSTRUCTION ACTIVITIES, OR CITATIONS EROSION CONTROL DEVICES SHALL BE INSTALLED AND MAINTAINED IN COMPLIANCE WITH THE PROJECT PLANS, CITY STORMWATER ORDINANCE AND/OR SWPPP AND CONSTRUCTION GENERAL PERMIT. THE CONTRACTOR SHALL INSPECT THE SITE DAILY AND KEEP THE SITE FREE OF TRASH AND CONSTRUCTION DEBRIS
- CONTRACTOR MUST EXECUTE AND KEEP A COPY OF THE CONSTRUCTION SITE NOTICE (CSN) FOR THOSE ACTIVITIES DISTURBING MORE THAN 1 ACRE AND A NOTICE OF INTENT (NOI) FOR THOSE ACTIVITIES DISTURBING 5 ACRES OR MORE.

### GENERAL NOTES FOR TRAFFIC CONTROL:

- CONTRACTOR SHALL PROVIDE THE PROJECT ENGINEER WITH A TRAFFIC CONTROL PLAN AT LEAST 10 BUSINESS DAYS BEFORE ANY WORK ON A CITY STREET. TRAFFIC CONTROL MEASURES SHALL CONFORM TO THE LATEST REVISION OF THE TEXAS MANUAL ON UNIFORM TRAFFIC CONTROL DEVICES (TMUTCD)
- CONTACT TRAFFIC ENGINEERING DIVISION, 972-216-6917, AT LEAST 48 HOURS PRIOR TO WORK REQUIRING THE REMOVAL OR RELOCATION OF TRAFFIC SIGNS, TRAFFIC CONTROL EQUIPMENT OR OTHER TRAFFIC CONTROL APPURTENANCES. ONLY
- IN THE EVENT THE CONSTRUCTION WORK REQUIRES THE CLOSURE OF AN EXISTING STREET, ALLEY, OR FIRE LANE, THE CONTRACTOR SHALL REQUEST THE ROAD CLOSURE THROUGH THE CITY INSPECTOR A MINIMUM OF 48 HOURS IN ADVANCE OF THE REQUESTED CLOSURE. CLOSURES WILL NOT BE ALLOWED PRIOR TO 9:00 A M. OR AFTER 3:30 P.M. MONDAY THROUGH FRIDAY UNLESS OTHERWISE APPROVED BY THE CITY. IN THE EVENT A DRIVEWAY(S) NEEDS TO BE CLOSED, THE CONTRACTOR SHALL REQUEST THE DRIVEWAY CLOSURE THROUGH THE CITY INSPECTOR, WHO WILL IN TURN NOTIFY DISPATCH AND OTHER PERTINENT CITY DEPARTMENTS. CLOSURES ARE PROHIBITED DURING SCHOOL ZONES TIMES IN AND
- IF THE CONSTRUCTION ZONE AFFECTS THE MOVEMENTS OF PEDESTRIANS, ADEQUATE PEDESTRIAN ACCESS AND WALKWAYS SHALL BE PROVIDED IN ACCORDANCE WITH THE DISABILITIES ACT ACCESSIBILITY GUIDELINES. PROWAG, TAS AND THE TMUTCD. WHERE DEVELOPMENTS OCCUR WITHIN 0.5 MILES OF A SCHOOL SITE, TEMPORARY SIDEWALKS MUST BE CONSTRUCTED CONNECTING THE DEVELOPMENT TO THE SCHOOL SITE. THE ROUTE SHALL BE APPROVED BY THE CITY ENGINEER. TEMPORARY SIDEWALKS MAY BE CONSTRUCTED WITH MATERIALS OTHER THAN CONCRETE. THE MATERIAL SHALL BE APPROVED BY THE CITY ENGINEER AND BE AN ALL-WEATHER MATERIAL OF A COLOR AND TEXTURE DISTINCTLY DIFFERENT FROM THE PERMANENT SIDEWALK.
- OVERNIGHT LANE CLOSURES SHALL BE APPROVED BY CITY PRIOR TO CLOSING THE LANE, ANY LANE OR SHOULDER CLOSURE ON AN ARTERIAL ROAD THAT EXTENDS INTO THE NIGHT SHALL REQUIRE THE MANDATORY USE OF ARROW

### GENERAL NOTES FOR PAVING

- ABSOLUTELY NO EARTHWORK, LIME APPLICATION, OR OTHER PREPARATION OF THE SUBGRADE FOR PAVING OF STREETS, ALLEYS, SIDEWALKS, TRAILS, FIRE LANES OR OTHER TRANSPORTATION RELATED FLATWORK SHALL BE INITIATED WITHOUT AUTHORIZATION FROM THE CITY. THE CITY WILL AUTHORIZE THE SUBGRADE WORK IN PREPARATION FOR PAVING AFTER UTILITY TRENCH BACKFILL TESTING HAS BEEN COMPLETED AND VERIFIED TO MEET THE CITY REQUIREMENTS
- 27. ALL SIDEWALKS SHALL COMPLY WITH THE AMERICANS WITH DISABILITIES ACT AND THE TEXAS ARCHITECTURAL BARRIERS. ACT. THE CITY OF MESQUITE HAS NOT REVIEWED THESE PLANS FOR COMPLIANCE WITH THE AMERICANS WITH DISABILITIES ACT, TEXAS ARCHITECTURAL BARRIERS ACT, OR ANY OTHER ACCESSIBILITY LEGISLATION, AND DOES NOT WARRANTY OR APPROVE THESE PLANS FOR ANY ACCESSIBILITY STANDARDS. PRIOR TO PROJECT ACCEPTANCE, THE CONTRACTOR SHALL SUBMIT TO THE CITY DOCUMENTATION THAT THE PROJECT WAS INSPECTED BY A REGISTERED ACCESSIBILITY SPECIALIST, REGISTERED WITH THE TEXAS DEPARTMENT OF LICENSING AND REGULATION CERTIFYING THE PROJECT IS IN COMPLIANCE. WITH THE REQUIREMENTS OF THE TEXAS ARCHITECTURAL BARRIERS ACT.
- ALL CONCRETE PAVING (STREETS, ALLEYS, SIDEWALKS, DRIVEWAYS) WITHIN CITY ROW SHALL HAVE A 28 DAY MINIMUM COMPRESSIVE STRENGTH OF 4,000 PSI, CONTAINING A MINIMUM OF 6 SACKS OF CEMENT PER CUBIC YARD, WITH A SLUMP RANGE OF 1" TO 3" SLUMP FOR MACHINE POURS AND 3" TO 5" SLUMP FOR HAND POURS UNLESS OTHERWISE NOTED IN THE GENERAL DESIGN STANDARDS. ALL MATERIALS AND REQUIREMENTS FOR CONCRETE SHALL CONFORM TO THE REQUIREMENTS OF THE CURRENT NOTCOG ITEM "PORTLAND CEMENT CONCRETE PAVEMENT" WITH THE EXCEPTION THAT FLY ASH MAY BE SUBSTITUTED FOR UP TO 20% OF THE CEMENT CONTENT REQUIREMENT AT 1 TO 1.25 CEMENT TO FLY ASH
- 29. ALL CONCRETE MUST BE MECHANICALLY VIBRATED. THE FORMING OF NEW STREET AND ALLEY PAVEMENT IS BY USING THE LIP FORM METHOD. CONCRETE SHALL BE HAND PLACED AT INTERSECTIONS AND MISCELLANEOUS AREAS
- TEMPERATURE DURING CONCRETE PLACEMENT:
  - THE TEMPERATURE OF CONCRETE AS PLACED SHALL NOT EXCEED 95°F. NO CONCRETE SHALL BE PLACED ON A FROZEN SUBGRADE.

OTHERWISE SPECIFIED, STEEL SHALL BE PLACED AT HALF THE PAVEMENT DEPTH.

- IF THE AMBIENT AIR TEMPERATURE IS LESS THAN 40°F AND DROPPING CONCRETE SHALL NOT BE PLACED.
- IF CONCRETE IS PLACED AND THERE IS AN ANTICIPATED LOW TEMPERATURE OF LESS THAN 40°F WITHIN 5 DAYS
  AFTER PLACEMENT THE CONCRETE MUST BE COVERED AND KEPT AT A TEMPERATURE OF NOT LESS THAN 50°F. IN ALL CASES, CONCRETE SHOULD NOT BE KEPT AT A TEMPERATURE OF LESS THAN 50°F FOR A PERIOD OF 5 DAYS
- REINFORCING SHALL CONFORM TO ASTM A 615 AND BE A MINIMUM GRADE OF 60 PER ASTM A 370. REINFORCING STEEL BAR LAPS ARE TO BE 30 BAR DIAMETERS OR 15" PER ACI 318, WHICHEVER IS GREATER, A MINIMUM OF 50% OF REBAR NTERSECTIONS ARE TO BE SECURED WITH TIE WIRE AND SUPPORTED WITH CHAIRS. ALL REINFORCEMENT SHALL BE FREE FROM RUST, SCALE, OIL, PAINT AND OTHER SUBSTANCES WHICH PREVENT BONDING TO THE CONCRETE, UNLESS
- WHITE CURING COMPOUND IS TO BE APPLIED, PER MANUFACTURER'S RECOMMENDATIONS, TO ALL EXPOSED CONCRETE SURFACES (INCLUDING BACKS OF CURBS) IMMEDIATELY AFTER COMPLETION OF FINISHING OPERATIONS, PER ASTM C-309, TYPE 2. NCTCOG SECTION 303 2 13 1 1.
- 33. NO VEHICLE TRAFFIC SHALL BE PERMITTED ON NEWLY PAVED AREAS FOR SEVEN DAYS AFTER CONCRETE POUR OR UNTIL
- 34. ALL FILL AND LIME SUBGRADES SHALL BE PLACED IN MAXIMUM 8" COMPACTED LIFTS AND BE COMPACTED TO 95% STANDARD PROCTOR AT A MOISTURE RANGE OF 0% TO 6% OF OPTIMUM MOISTURE. MOISTURE LEVEL MUST BE MAINTAINED, BY WETTING OR APPLICATION OF ASPHALT EMULSION PRIME COAT (0.25 TO 0.50 GAL/SY) IF NECESSARY, UNTIL

REQUIRED TESTING					
MATERIAL	DESIGNATION	TEST	FREQUENCY	REQUIREMENTS	NOTES
		IN-PLACE DENSITY AND WATER CONTENT	EVERY 300 LINEAR FEET (1)	MOISTURE CONTENT: 0% - 6% OF OPTIMUM; DENSITY: 95% OF STANDARD PROCTOR	EVERY 8" LIFT
SUBGRADE	ASTM D-6938	LIME STABILIZED SUBGRADE - DEPTH CHECK		DEPTH OF STABILIZATION AS SPECIFIED PER PLANS	
		LIME STABILIZED SUBGRADE - SIEVE ANALYSIS		1.75" SIEVE: 100% PASSING; NO. 4 SIEVE: 60%	
	ASTM D-698	PROCTOR	EVERY NEW MATERIAL SOURCE		
	ASTM C- 143	SLUMP OF PORTLAND CEMENT	FIRST TRUCK EACH DAY + 1 EVERY 150 CY	1" - 3" MACHINE POURS; 3" - 5" HAND POURS	
	ASTM C-231	CONCRETE AIR CONTENT BY PRESSURE METHOD (FOR FRESH CONCRETE)	FIRST TROCK EACH DAT + TEVERT 130 CT	MINIMUM 3%	
	ASTM C- 1064	TEMPERATURE OF FRESHLY MIXED PORTLAND CEMENT CONCRETE	EVERY TRUCK	95 F MAX (HOT WEATHER) AND 50 F MIN (COLD WEATHER)	
CONCRETE PAVING	ASTM C-39	COMPRESSIVE STRENGTH OF CYLINDRICAL CONCRETE SPECIMENS	3 CYLCINDERS TAKEN FROM FIRST TRUCK EVERY DAY + 3 EVERY 150 CY	3,000 PSI MINIMUM FOR TRAFFIC; 4,000 PSI MINIMUM AT 28 DAYS	1 BROKEN AT 7 DAYS AND THE OTHER 2 BROKEN AT 28 DAYS; IF NEEDING TO GE TRAFFIC ON PAVEMENT FASTER THEN ADDITIONAL CYLINDER BROKEN AT 3 DAYS
	ASTM C-42	OBTAINING AND TESTING OF DRILLED CORES OF CONCRETE	EVERY 300 LINEAR FEET (1)	4,000 PSI COMPRESSIVE AT 28 DAYS	4" DIAMETER TAKEN 28 DAYS AFTER POUR
	ASTM C-174	MEASURING LENGTH OF DRILLED CONCRETE CORES	TEVERY SOU LINEAR FEET (I)	DEPTH OF PAVEMENT AS SPECIFIED PER PLANS	

GENERAL DESIGN STANDAR

CITY OF MESQUITE, TEXAS PUBLIC WORKS DEPARTMENT STANDARD DETAILS

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ITEM NO	ITEM DESCRIPTION	UNITS	PLAN QUANTITIES	BID QUANTITIES
1	Mobilization	LS	1	1
2	Traffic Control Implementation and Maintenance	LS	1	1
3	Preparation and Implementation of SWPPP	LS	1	1
4	Mill Existing Asphalt Pavement (Approximate 2"), Complete in Place	SY	5835	6100
5	Furnish and Install 2" HMAC, Type D Overlay	SY	5835	6100
6	Furnish and Install 3" HMAC, Type D Surface Course at Widen and Utility Cut Areas	SY	1170	1300
7	Furnish and Install Compacted Flexible Base, TXDOT Item 247, Grade 1, Type D	CY	200	220
8	Unclassified Excavation	CY	160	200
9	Markout Central Temp. Repair Allowance	AL	1	1



Public Works EXISTING UTILITIES AND UNDERGROUND FACILITIES INDICATED ON THESE PLANS HAVE BEEN LOCATED FROM REFERENCE INFORMATION. IT SHALL BE THE RESPONSIBILITY OF THE CONTRACTOR TO VERIFY BOTH HORIZONTALLY AND VERTICALLY THE LOCATION OF EXISTING UTILITIES AND UNDERGROUND FACILITIES PRIOR TO CONSTRUCTION, TO TAKE THE NECESSARY PRECAUTIONS IN ORDER TO PROTECT ALL FACILITIES ENCOUNTERED. THE CONTRACTOR SHALL PRESERVE AND PROTECT ALL EXISTING UTILITIES FROM DAMAGE DURING CONSTRUCTION.

WISER ROAD RECONSTRUCTION CITY CONTRACT # 2024-101


**QUANTITY SHEET** 


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SHEET: 3 OF 16

DATE: 01/16/2024





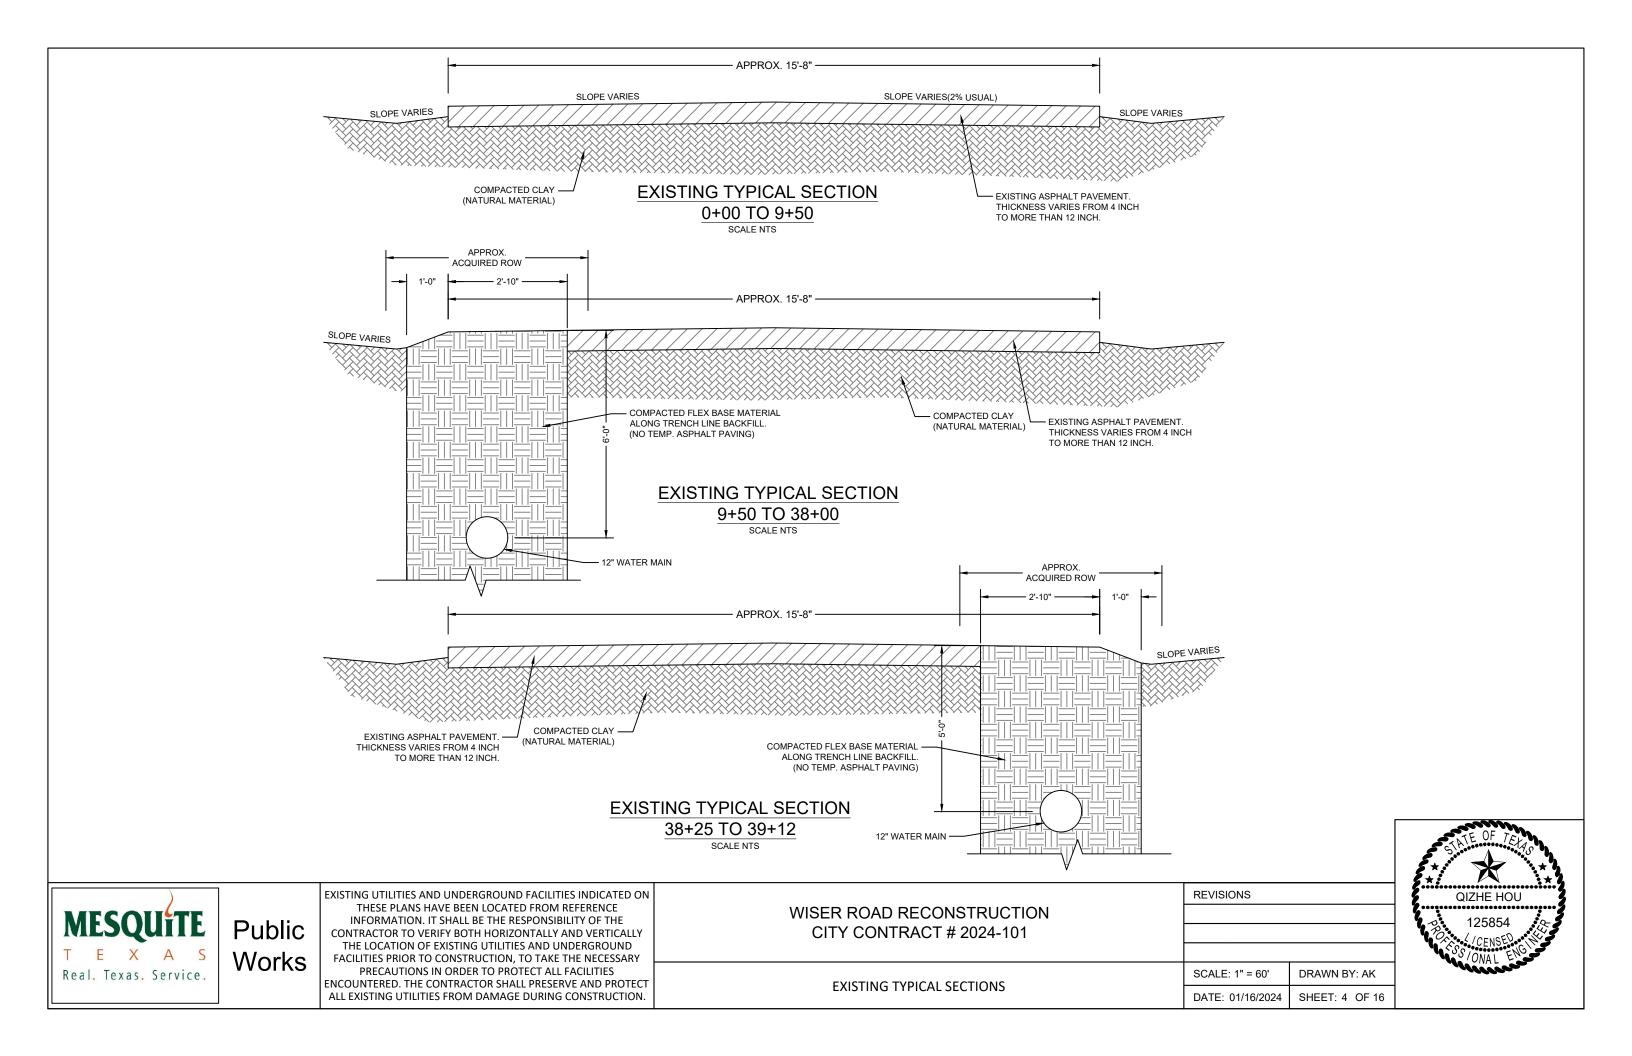

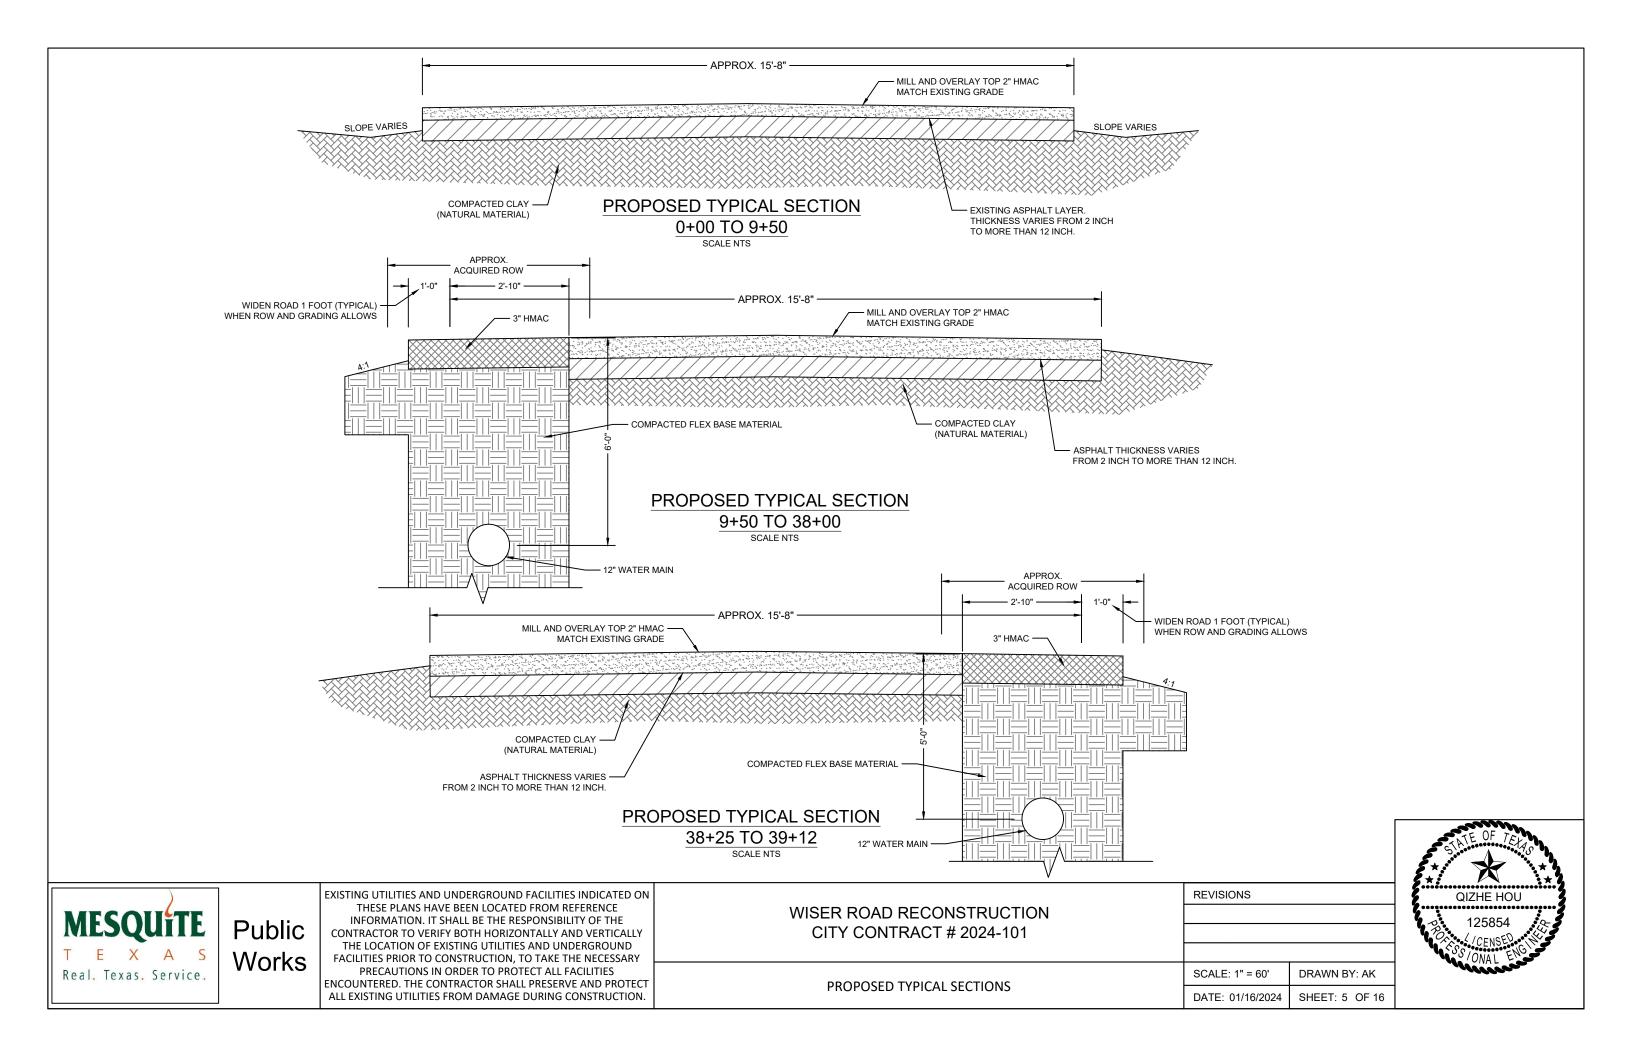



 ALL LOCATIONS AND LIMITS SHOWN ARE APPROXIMATE. THE CITY OF MESQUITE CONSTRUCTION INSPECTOR WILL MARK REMOVAL LIMITS IN FIELD WHEN REQUESTED BY CONTRACTOR. CONTRACTOR SHALL FOLLOW MARKINGS IN FIELD ON EXACT LOCATIONS AND LIMITS.

ALL WORK SHALL COMPLY WITH CITY OF MESQUITE GENERAL DESIGN STANDARDS.

 CONTRACTOR SHALL PROVIDE TRAFFIC CONTROL IN ACCORDANCE WITH THE CURRENT TEXAS MANUAL OF UNIFORM TRAFFIC CONTROL DEVICES.

UNIFORM TRAFFIC CONTROL DEVICES.

ADJUSTMENT OF EXISTING WATER METERS, WATER VALVE STACKS AND MANHOLES SHALL BE COMPLETED AS NECESSARY TO ENSURE UTILITY APPURTENANCES ARE LEVEL WITH FINAL SURROUNDING GRADES.



Public Works

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### WISER ROAD RECONSTRUCTION CITY CONTRACT # 2024-101

STREET REPAIR FOR WISER RD - 1


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DATE: 01/16/2024 | SHEET: 6 OF 16

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DANIEL ROBERT BRUMMETT - 2,053 SF (15558 COUNTY RD 200, FORNEY, TX 75126)



KENNETH AND PAMELA HILL - 8,523 SF (15530 WISER RD, FORNEY, TX 75126)

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### WISER ROAD RECONSTRUCTION CITY CONTRACT # 2024-101

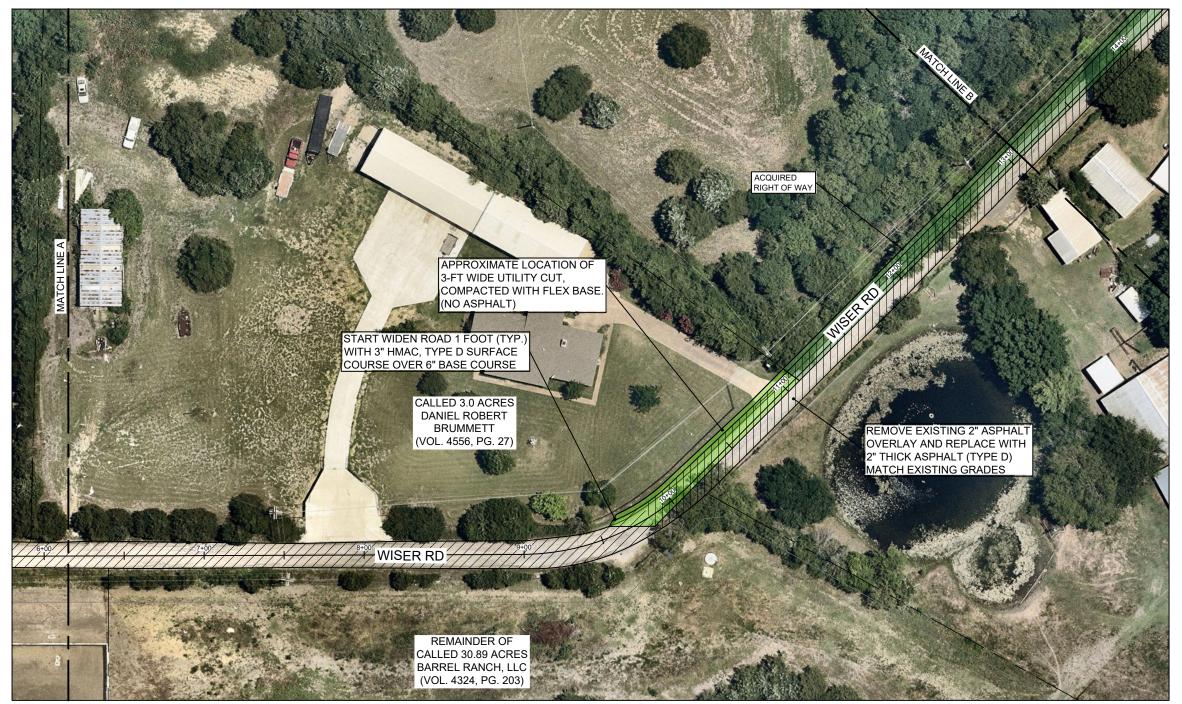STREET REPAIR FOR WISER RD - 2

NEY, TX 75126)					
REVISIONS					
SCALE: 1" = 60'	DRAWN BY: AK				
DATE: 01/16/2024	SHEET: 7 OF 16				



GRAPHIC SCALE IN FEET

SEWER MANHOLE
STORM INLET
WATER METER
FIRE HYDRANT
WATER VALVE
EXISTING

WATER LINE

ASPHALT MILL

& OVERLAY

STORM LINE

ss — SEWER LINE





KENNETH AND PAMELA HILL - 8,523 SF (15530 WISER RD, FORNEY, TX 75126)



CHARLES AND FLORENCE BENEDICT - 8,523 SF (15429 WISER RD. FORNEY TX 75126)




Public Works

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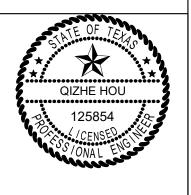
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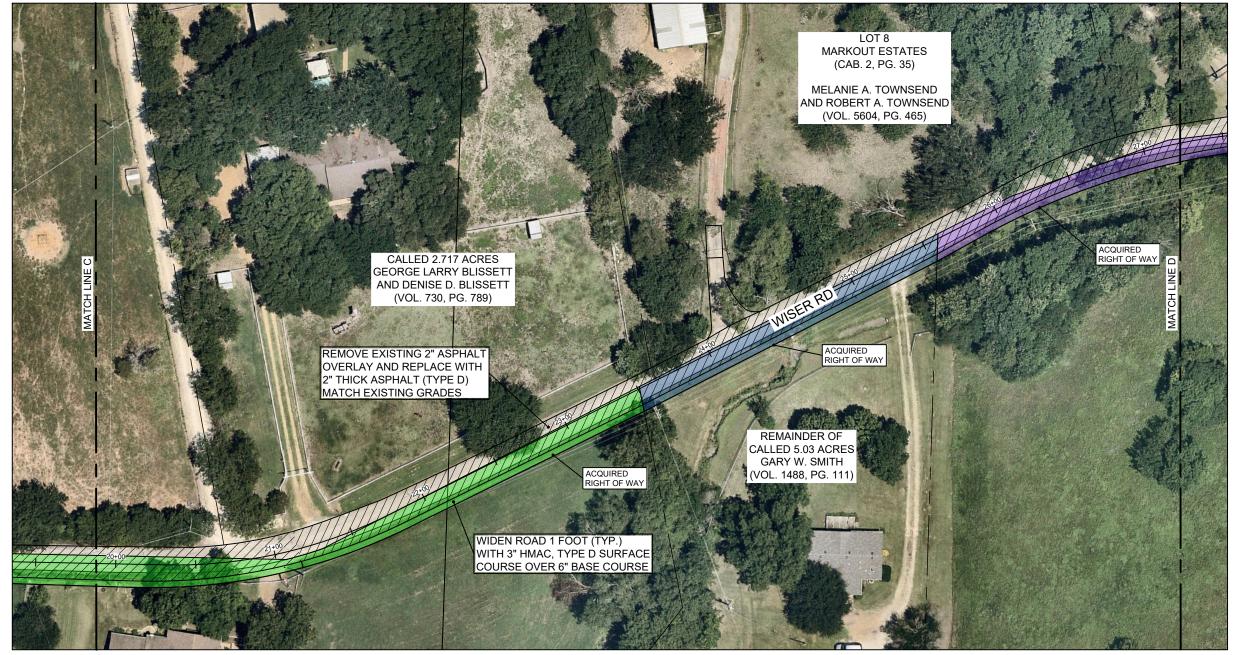
STREET REPAIR FOR WISER RD - 3

SCALE: 1" = 60' DRAWN BY: AK
DATE: 01/16/2024 SHEET: 8 OF 16



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ACQUIRED R.O.W.

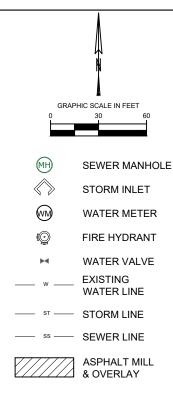

CHARLES AND FLORENCE BENEDICT - 8,523 SF (15429 WISER RD, FORNEY, TX 75126)



GARY SMITH - 3,352 SF (15311 WISER RD, FORNEY, TX 75126)



JYZ PROPERTIES - 9,479 SF (INTERSTATE 20, FORNEY, TX 75126)

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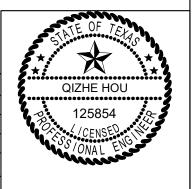


Public Works EXISTING UTILITIES AND UNDERGROUND FACILITIES INDICATED ON THESE PLANS HAVE BEEN LOCATED FROM REFERENCE INFORMATION. IT SHALL BE THE RESPONSIBILITY OF THE CONTRACTOR TO VERIFY BOTH HORIZONTALLY AND VERTICALLY THE LOCATION OF EXISTING UTILITIES AND UNDERGROUND FACILITIES PRIOR TO CONSTRUCTION, TO TAKE THE NECESSARY PRECAUTIONS IN ORDER TO PROTECT ALL FACILITIES ENCOUNTERED. THE CONTRACTOR SHALL PRESERVE AND PROTECT ALL EXISTING UTILITIES FROM DAMAGE DURING CONSTRUCTION.

# WISER ROAD RECONSTRUCTION CITY CONTRACT # 2024-101

STREET REPAIR FOR WISER RD - 4

REVISIONS	
SCALE: 1" = 60'	DRAWN BY: AK
DATE: 01/16/2024	SHEET: 9 OF 16





JYZ PROPERTIES - 9,479 SF (INTERSTATE 20, FORNEY, TX 75126)



BEN AND KAY HINDS - 4.313 SF (15180 WISER RD, FORNEY, TX 75126)



TOMMY AND DORIS SHELLEY - 4.289 SF (15154 WISER RD, FORNEY, TX 75126)

- ALL LOCATIONS AND LIMITS SHOWN ARE APPROXIMATE. THE CITY OF MESQUITE CONSTRUCTION INSPECTOR WILL MARK REMOVAL LIMITS IN FIELD WHEN REQUESTED BY CONTRACTOR.
- ACCORDANCE WITH THE CURRENT TEXAS MANUAL OF
- UNIFORM TRAFFIC CONTROL DEVICES.

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Public Works


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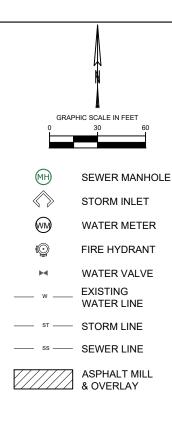
# WISER ROAD RECONSTRUCTION **CITY CONTRACT # 2024-101**

STREET REPAIR FOR WISER RD - 5

REVISIONS	
SCALE: 1" = 60'	DRAWN BY: AK
DATE: 01/16/2024	SHEET: 10 OF 16





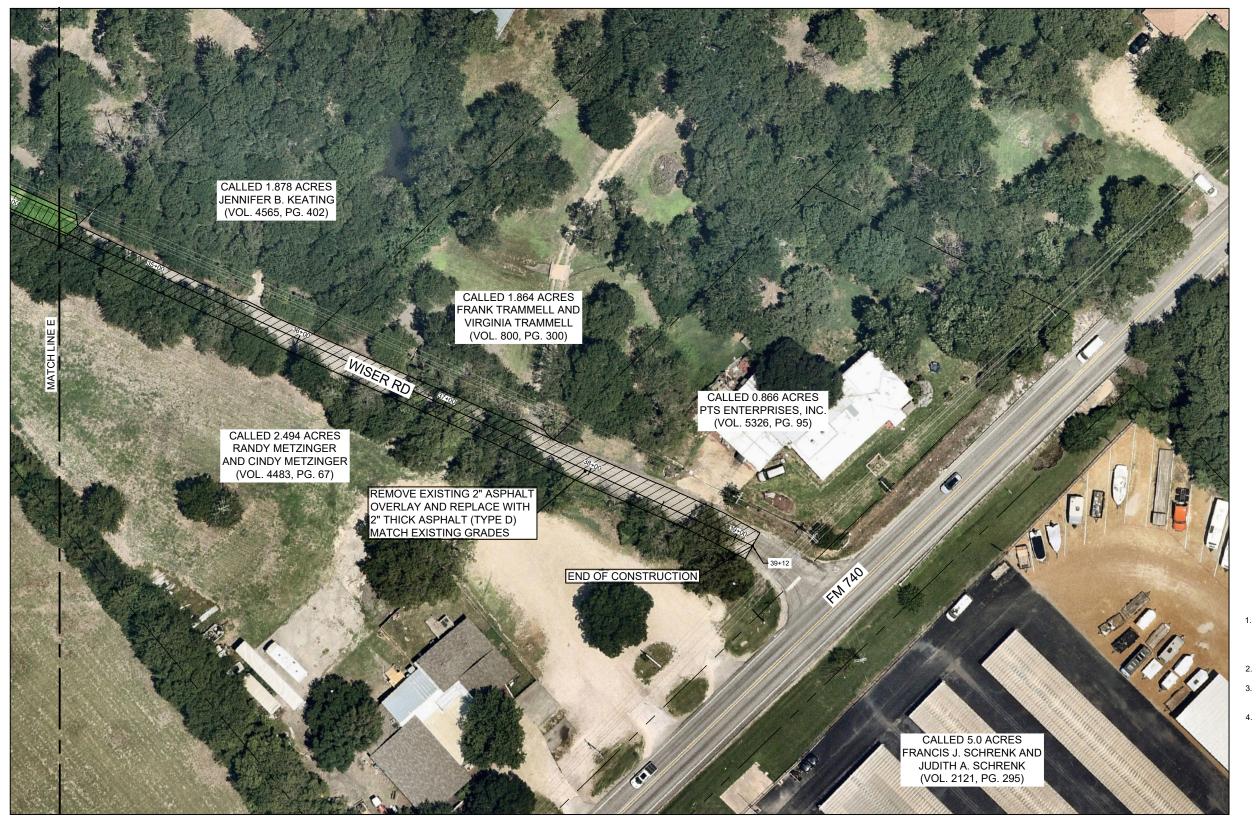

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- CONTRACTOR SHALL PROVIDE TRAFFIC CONTROL IN ACCORDANCE WITH THE CURRENT TEXAS MANUAL OF LINEORM TRAFFIC CONTROL DEVICES.
- UNIFORM TRAFFIC CONTROL DEVICES.

  4. ADJUSTMENT OF EXISTING WATER METERS, WATER VALVE STACKS AND MANHOLES SHALL BE COMPLETED AS NECESSARY TO ENSURE UTILITY APPURTENANCES ARE LEVEL WITH FINAL SURROUNDING GRADES.



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WISER ROAD RECONSTRUCTION CITY CONTRACT # 2024-101

> STREET REPAIR FOR WISER RD - 6

SCALE: 1" = 60' DRAWN BY: AK

SHEET: 11 OF 16

DATE: 01/16/2024







DANIEL ROBERT BRUMMETT - 2,053 SF (15558 COUNTY RD 200, FORNEY, TX 75126)



KENNETH AND PAMELA HILL - 8,523 SF (15530 WISER RD, FORNEY, TX 75126)

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# WISER ROAD RECONSTRUCTION CITY CONTRACT # 2024-101

APPROXIMATE TRENCH LOCATION WISER RD - 1

NEY, TX 75126)			
REVISIONS			
SCALE: 1" = 60'	DRAWN BY: AK		
DATE: 01/16/2024	SHEET: 12 OF 16		



GRAPHIC SCALE IN FEET

W \_\_\_\_ EXISTING WATER LINE

ST \_\_\_ STORM LINE

SS \_\_\_ SEWER LINE

ASPHALT MILL & OVERLAY

SEWER MANHOLE
STORM INLET
WATER METER
FIRE HYDRANT
WATER VALVE



REFER TO WISER ROAD WL PLAN FOR UTILITY CUT LOCATION FOR NEXT SEVERAL

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KENNETH AND PAMELA HILL - 8,523 SF (15530 WISER RD, FORNEY, TX 75126)



CHARLES AND FLORENCE BENEDICT - 8,523 SF



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# WISER ROAD RECONSTRUCTION **CITY CONTRACT # 2024-101**

APPROXIMATE TRENCH LOCATION WISER RD - 2

D, FORNEY, TX 75126)			
REVISIONS			
SCALE: 1" = 60'	DRAWN BY: AK		
DATE: 01/16/2024	SHEET: 13 OF 16		



GRAPHIC SCALE IN FEET

SEWER MANHOLE STORM INLET WATER METER FIRE HYDRANT WATER VALVE **EXISTING** 


WATER LINE

ASPHALT MILL & OVERLAY

— STORM LINE

ss — SEWER LINE



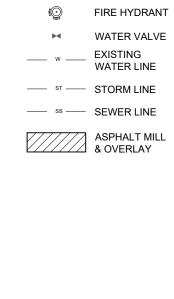

GRAPHIC SCALE IN FEET

SEWER MANHOLE
STORM INLET
WATER METER

ACQUIRED R.O.W.



CHARLES AND FLORENCE BENEDICT - 8,523 SF (15429 WISER RD, FORNEY, TX 75126)



GARY SMITH - 3,352 SF (15311 WISER RD, FORNEY, TX 75126)



JYZ PROPERTIES - 9,479 SF (INTERSTATE 20, FORNEY, TX 75126)

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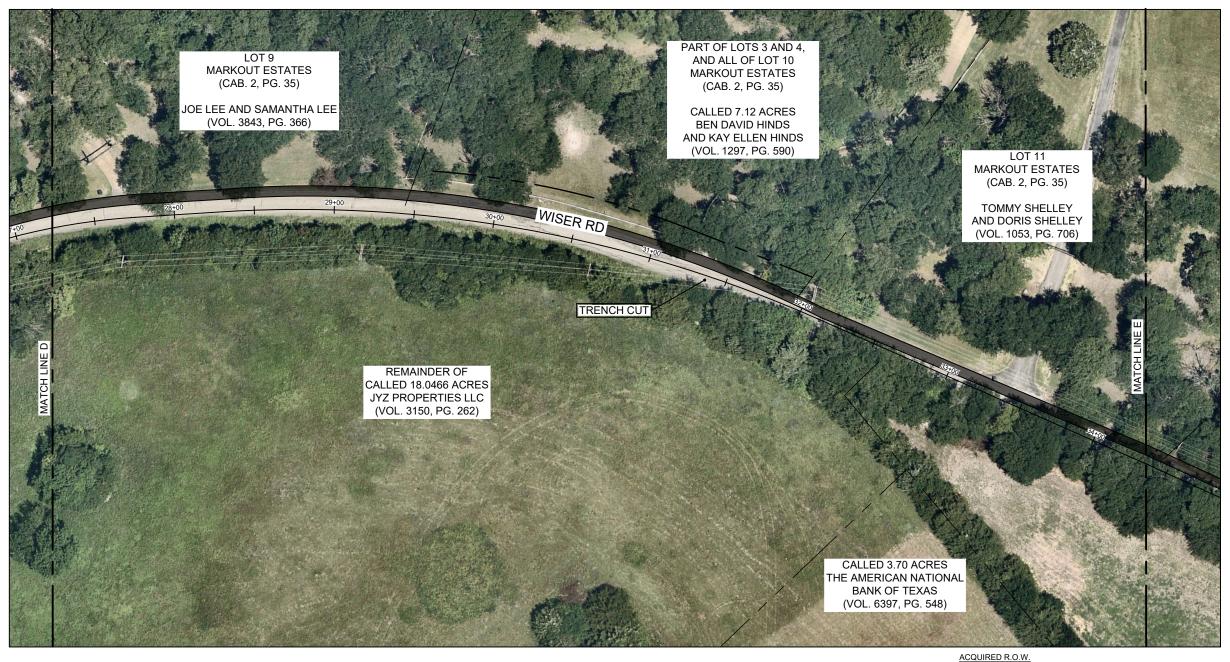
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# WISER ROAD RECONSTRUCTION CITY CONTRACT # 2024-101

APPROXIMATE TRENCH LOCATION WISER RD - 3

REVISIONS				
SCALE: 1" = 60'	DRAWN BY: AK			
DATE: 01/16/2024	SHEET: 14 OF 16			





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(15180 WISER RD, FORNEY, TX 75126)

TOMMY AND DORIS SHELLEY - 4,289 SF (15154 WISER RD, FORNEY, TX 75126)

JYZ PROPERTIES - 9,479 SF

(INTERSTATE 20, FORNEY, TX 75126)

BEN AND KAY HINDS - 4,313 SF



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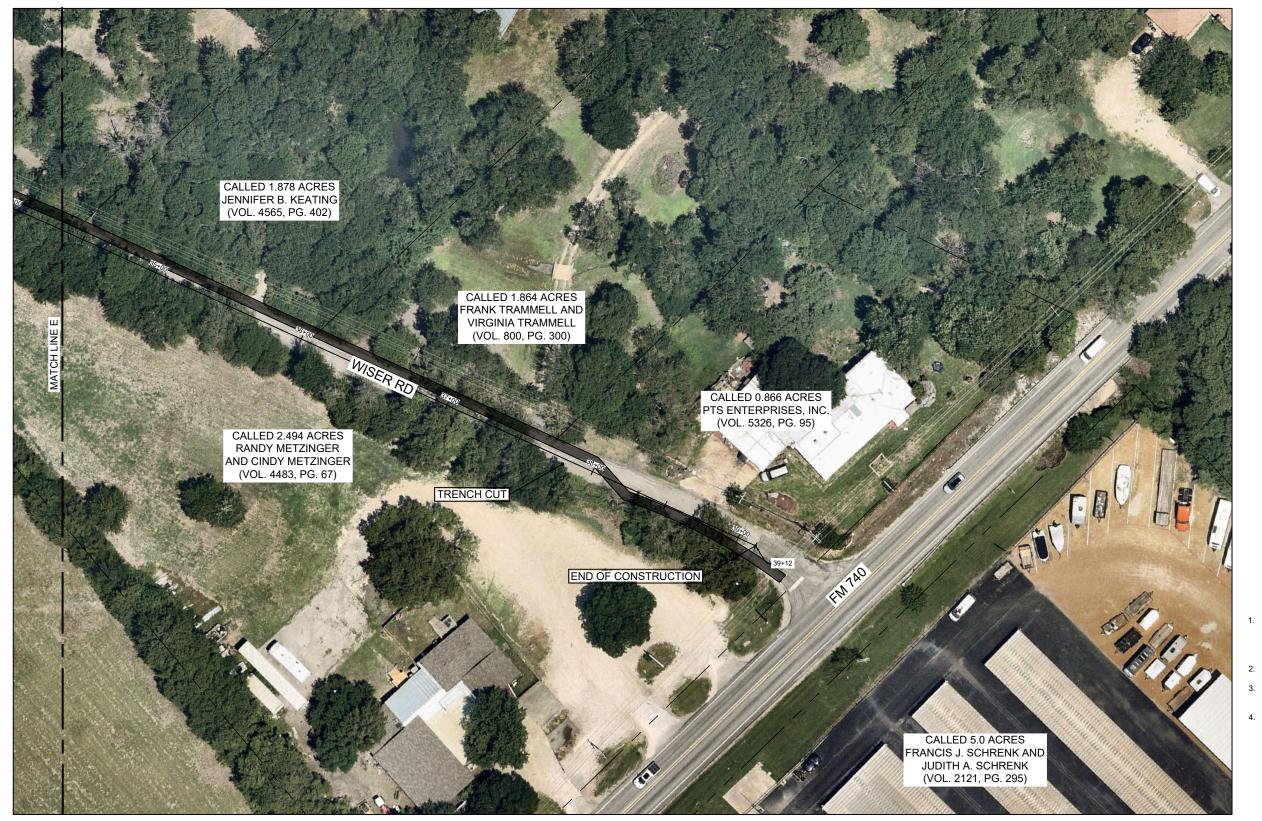
# WISER ROAD RECONSTRUCTION **CITY CONTRACT # 2024-101**


APPROXIMATE TRENCH LOCATION WISER RD - 4

REVISIONS	
SCALE: 1" = 60'	DRAWN BY: AK
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WISER ROAD RECONSTRUCTION **CITY CONTRACT # 2024-101** 

APPROXIMATE TRENCH LOCATION WISER RD - 5

**REVISIONS** SCALE: 1" = 60' DRAWN BY: AK

SHEET: 16 OF 16

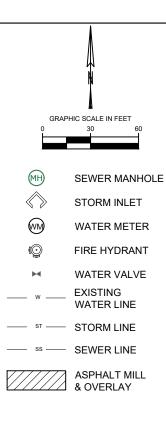DATE: 01/16/2024

